

ONONDAGA COUNTY  
DEPARTMENT OF DRAINAGE AND SANITATION

GARAGE MODIFICATIONS AT:

Meadowbrook-Limestone Wastewater Treatment Plant

Town of Manlius

Manlius, New York

PROJECT NO. 587353  
BID REFERENCE NO. 4576

CONTRACT 4A - GENERAL  
CONTRACT 4B - ELECTRICAL  
CONTRACT 4C - HEATING AND VENTILATING  
CONTRACT 4D - PLUMBING

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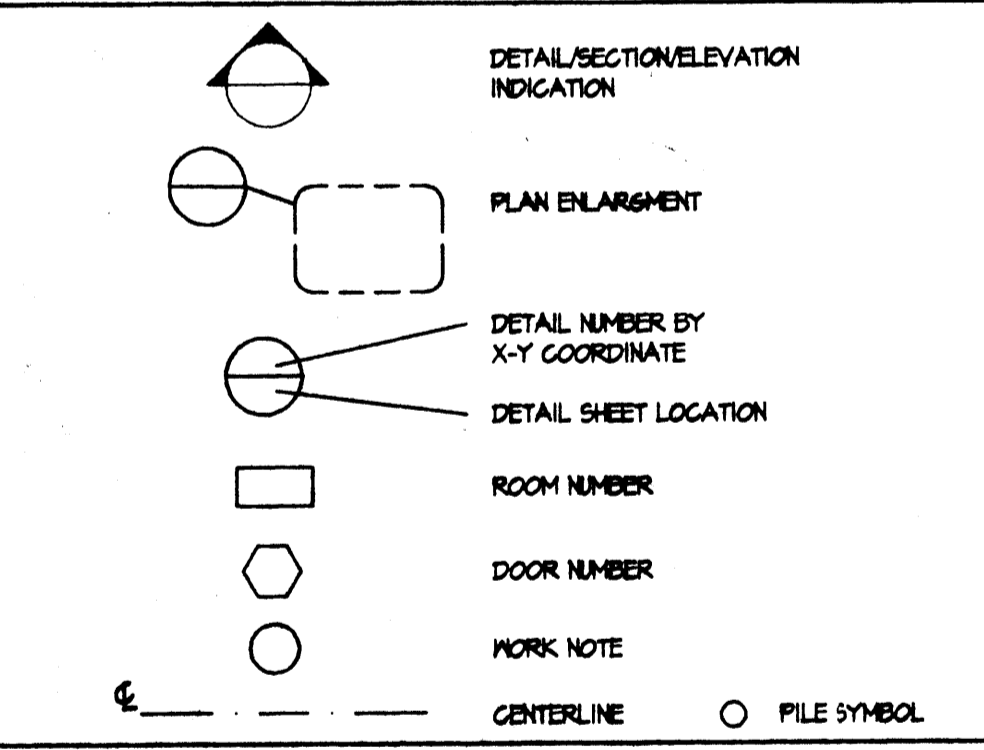


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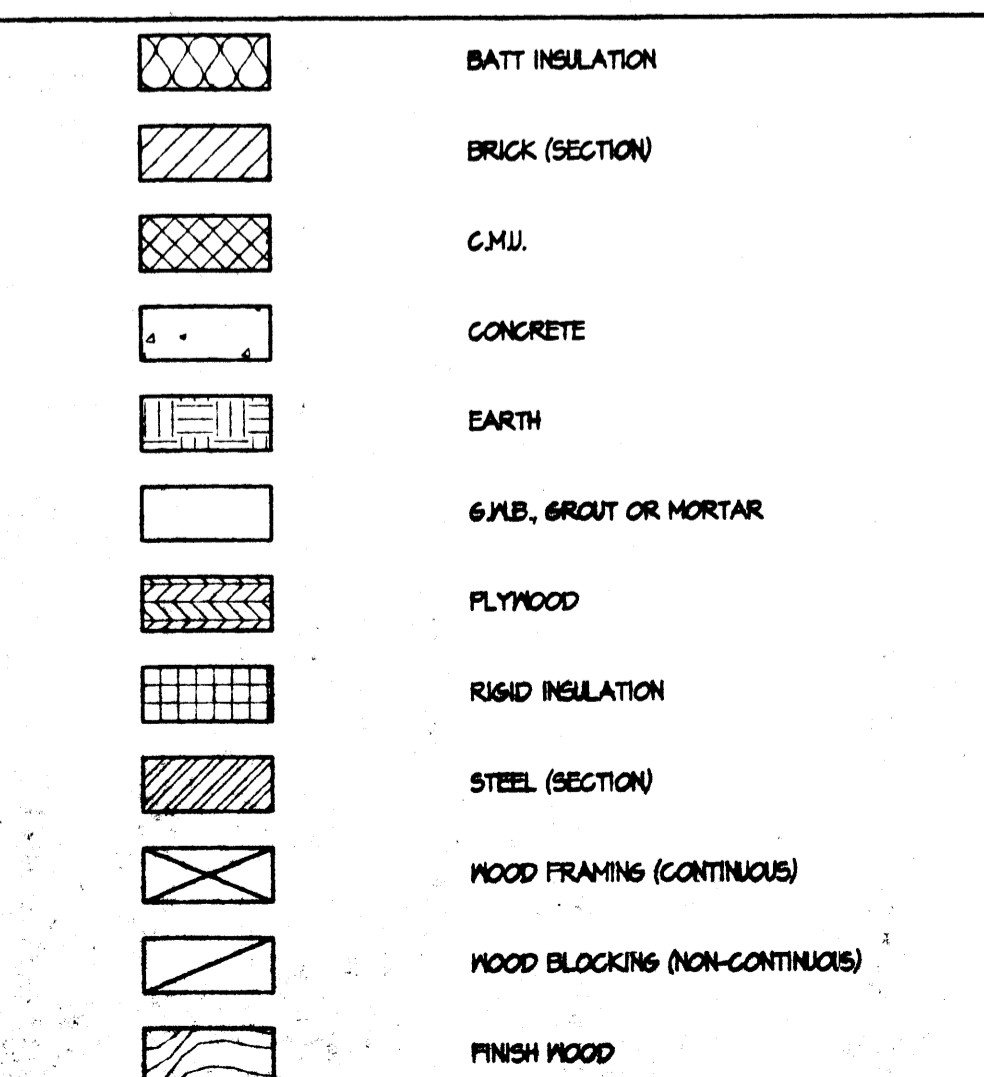
It is a violation of the New York State Professional Engineering Law for any person, who acting as a licensed registered professional engineer, to practice in any way, which may be construed as the practice of a profession, without being duly licensed and registered in accordance with the provisions of the law.



SYMBOLS




MATERIALS LEGEND



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LOCATION MAP




ABBREVIATIONS

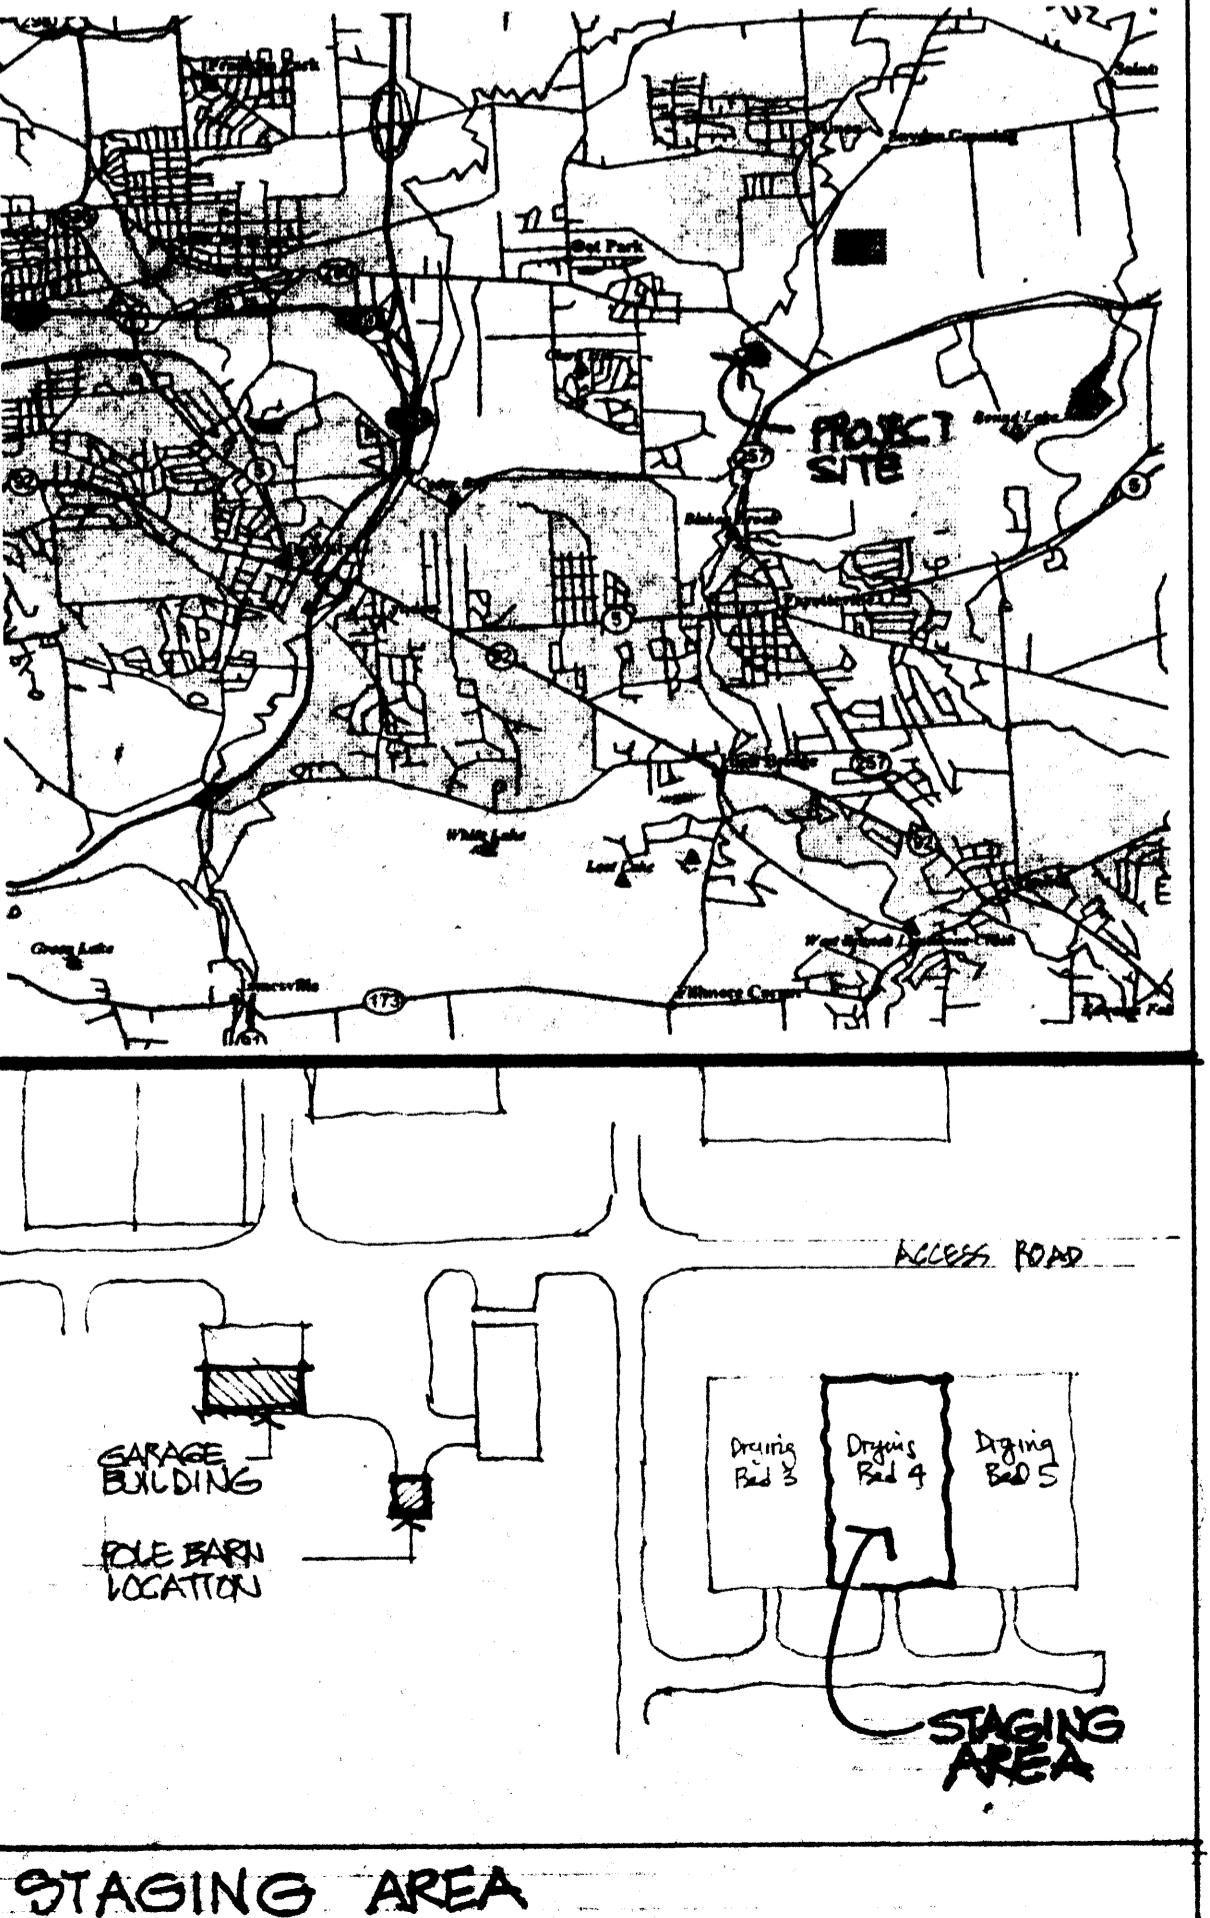AFF	ABOVE FINISH FLOOR	EA	EACH	HP	HORSEPOWER	P.C.	PLUMBING CONTRACTOR	TEL	TELEPHONE
AF	ABOVE FLOOR	E.F.	EACH FACE	HB	HOSE BIB	PLND	PLYWOOD	TEMP	TEMPERATURE
AP	ACCESS PANEL	E.M.	EACH MAY	IN	INCHES	PVC	POLYVINYL CHLORIDE	TEMP	TEMPERED
AC.T	ACOUSTICAL TILE	ELEC.	ELECTRIC	I.D.	INSIDE DIAMETER	PROF.	PREFINISHED	T.P.	TEMPERED PLATE
AC.P	ACOUSTICAL CEILING PANEL	ELEV.	ELEVATION	I.F.	INSIDE FACE	P.E.J.M.	PREFOLDED EXPANSION	TERR.	TERRAZZO
ADJ.	ADJUSTABLE/ADJACENT	E.G.	ELECTRICAL CONTRACTOR	INSUL.	INSULATION	P.R.V.	POWER ROOF VENTILATOR	T.L.T.	TILE
A.L.T.	ALTERNATE	ENGR.	ENGINEER	INT.	INTERIOR	P.V.	PLUMBING VENT	T & B	TONGUE AND GROOVE
ALUM.	ALUMINUM	EQUIP.	EQUIPMENT	INV.	INVERT	Q.T.	QUARRY TILE	T.C.	TOP AND BOTTOM
ANCH.	ANCHOR	EXH.	EXHAUST	I.P.	IRON PIPE	RAD.	RADIATION OR RADIUS	T.C.	TOP CHORD
AB	ANCHOR BOLT	EX.PAN.	EXPANSION	JAN.	JANITOR	R.	RISER	T.C.	TOP CONCRETE
AD.	AREA DRAIN	E.J.	EXPANSION JOINT	J.T.	JOIST	REF.	REFERENCE/REFRIGERATOR	T.C.	TOP OF BLOCK
		EXP.	EXPOSED	JST.	JOIST	REG.	REGISTER	T.C.	TOP OF FOOTING
		EX/EXIST.	EXISTING	LAM.	LAMINATE	REIN.	REINFORCING	T.C.	TOP OF MASONRY
		EXT.	EXTERIOR	LAV.	LAVATORY	REIN.	REINFORCING	T.C.	TOP OF STEEL
B	BASE	F.O.	FACE OF	L.P.	LIGHT PANEL	RELOC.	RELOCATE	T.C.	TYPICAL
BM	BEAM	F.F.	FACE TO FACE	LOC.	LOCATION	REQ'D/REQ.	REQUIRED	T.C.	TYPICAL
BN	BULL NOSE	FIN.	FINISH	LL.V.	LONG LEG VERTICAL	RF6.	ROOFING	T.C.	TYPICAL
BT	BITUMINOUS	F.D.	FLOOR DRAIN	LL.H.	LONG LEG HORIZONTAL	R.D.	ROOF DRAIN	T.C.	TYPICAL
BLK./BLK'S.	BLOCKING	F.E.	FIRE EXTINGUISHER	LL.M.	LONG LEG MASONRY	R.L.	ROOF LEADER	T.C.	TYPICAL
BOT.	BOTTOM	F.R.	FIRE RATED	L.S.F.	LONG LEG FRAMING	R.V.	ROOF VENT	T.C.	TYPICAL
B.O.	BOTTOM OF / BY OTHERS	FL.	FLOOR	LTMT.	LIGHTWEIGHT	RM.	ROOM	T.C.	TYPICAL
B.C.	BOTTOM CHORD	FTG.	FOOTING	M.H.	MANHOLE	R.O.	ROUGH OPENING	T.C.	TYPICAL
BRK.	BRICK	F.S.	FOOTING STEP	MFR.	MANUFACTURER	RUB.	RUBBER	T.C.	TYPICAL
BLDG.	BUILDING	FND./FOUND.	FOUNDATION	MAS.	MASONRY	R.O.B.	RUN OF BANK	T.C.	TYPICAL
BU.	BUILT UP	FUR.	FURRING/FURRED	MAT.	MATERIAL	RT.U.	ROOF TOP UNIT	T.C.	TYPICAL
		F.R.	FIRE RATED	MAY.	MATERIAL	R.B.	RUBBER BASE	T.C.	TYPICAL
¢/CL	CENTERLINE	GA.V.	GALVANIZED	MECH.	MECHANICAL	R.T.	RUBBER TILE	T.C.	TYPICAL
CAB.	CABINET	GA.	GAUGE	MET./MTL.	METAL	SAN.	SANITARY	T.C.	TYPICAL
C.U.H.	CABINET UNIT HEATER	G.C.	GENERAL CONSTRUCTION	MIN.	MINIMUM	SCH.	SCHEDULE	T.C.	TYPICAL
CRPT.	CARPET	G.L.	GLASS	MISC.	MISCELLANEOUS	S.D.	SCUPPER DRAIN	T.C.	TYPICAL
C.I.P.	CAST-IN-PLACE OR CAST IRON PIPE	G.C.T.	GLAZED CERAMIC TILE	M.O.	MASONRY OPENING	SH.	SHOWER	T.C.	TYPICAL
C.B.	CATCH BASIN	G.C.F.	GLAZED WALL FINISH	MOS.	MOSAIC	SHR/SHR.	SHOWER	T.C.	TYPICAL
C.E.	CENT. PLASTER	GR.	GRADE	M.H.	MOUNTING HEIGHT	SIM.	SIMILAR	T.C.	TYPICAL
C.NTR./CTR.	CENTER	GRD.	GROUND	N.C.	NOT IN CONTRACT	S.L.	SIMILAR	T.C.	TYPICAL
C.C.	CENTER TO CENTER	GYP.	GYPSONUM	N.G.	NOT IN CONTRACT	S.P.A.	SPECIFICATION	T.C.	TYPICAL
C.M.T.	CERAMIC MOSAIC TILE	G.Y.B.	GYPSONUM BOARD	O.C.	ON CENTER	S.P.	SPRINKLER	T.C.	TYPICAL
C.T.	CERAMIC TILE	G.Y.M.	GYPSONUM DRY-MIX	OPNS.	OPENING	SQ.	SQUARE	T.C.	TYPICAL
C.O.	CLEAN OUT	H.D.B.	HARD BOARD	OPPS.	OPPOSITE	SQ.FT.	SQUARE FOOT	T.C.	TYPICAL
CLR.	CLEAR	H.D.V.	HARDWARE	O.D.	OUTSIDE DIAMETER	SQ.IN.	SQUARE INCH	T.C.	TYPICAL
CL./GLOS.	CLOSET	H.W.D.	HARDWOOD	O.F.	OUTSIDE FACE	S.	STAIN	T.C.	TYPICAL
COL.	COLUMN	HTR.	HEATER	O. TO O. or O/O	OUT TO OUT	S.S.	STAINLESS STEEL	T.C.	TYPICAL
CONC.	CONCRETE	H.V.	HEATING AND VENTILATING	OHD.	OVERHEAD	STD.	STANDARD	T.C.	TYPICAL
C.M.U.	CONCRETE MASONRY UNIT	HVAC	HEATING/VENTILATION & AIR CONDITIONING	PT.	PAINT	S.K.V.	STATIONARY ROOF VENT	T.C.	TYPICAL
CONT.	CONTINUOUS	H.C.	HEIGHT	FR.	FRAMING	STL.	STEEL	T.C.	TYPICAL
C.L.	CONTROL JOINT	H.D.L.	HOLLOW METAL	FRK./PART.	FRAMING PART	S.T.	STORAGE	T.C.	TYPICAL
CORR.	CORRIDOR	H.M.	HOLLOW METAL	PLAS.	PLASTER/PLASTIC	STR.	STRUCTURE	T.C.	TYPICAL
C.CRS.	COURSE(S)	H.H.	HORIZONTAL	PL.	PLUMBING	SUSP.	SUSPENDED	T.C.	TYPICAL
D.P.C.O.	DECK PLATE CLEAN OUT	H.H.	HORIZONTAL	P & M	PATCH AND MATCH	SYM.	SYMMETRICAL	T.C.	TYPICAL
DET.	DETAIL							T.C.	TYPICAL
DIA.	DIAMETER							T.C.	TYPICAL
DM.	DIMENSION							T.C.	TYPICAL
DR.	DOOR							T.C.	TYPICAL
DN.	DOWN							T.C.	TYPICAL
DRG.	DRAWING							T.C.	TYPICAL
D.F.	DRINKING FOUNTAIN							T.C.	TYPICAL

GARAGE MODIFICATIONS AT:  
**MEADOWBROOK-LIMESTONE WASTEWATER TREATMENT PLANT**  
TOWN OF MANLIUS  
SYRACUSE • FRAGOLA / ARCHITECTS


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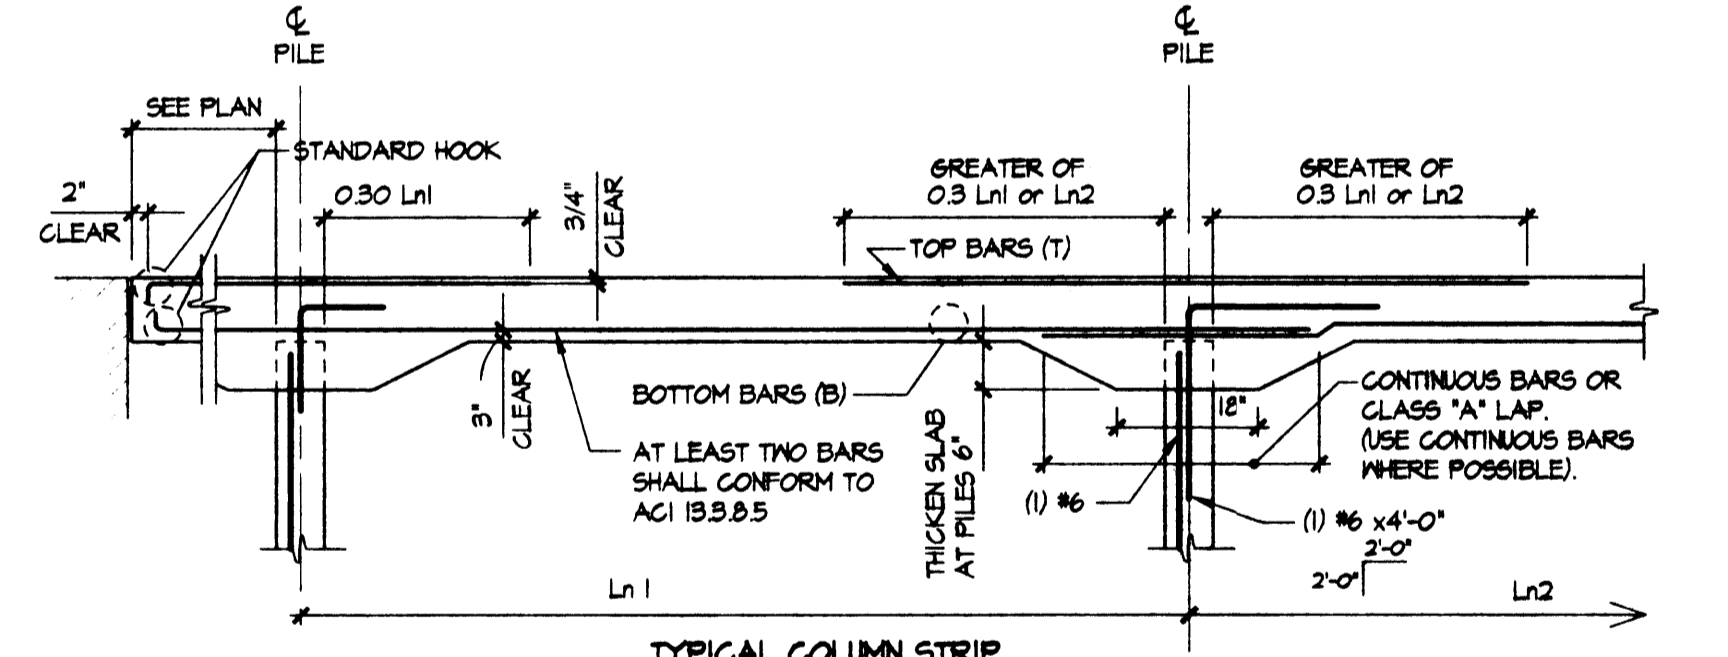
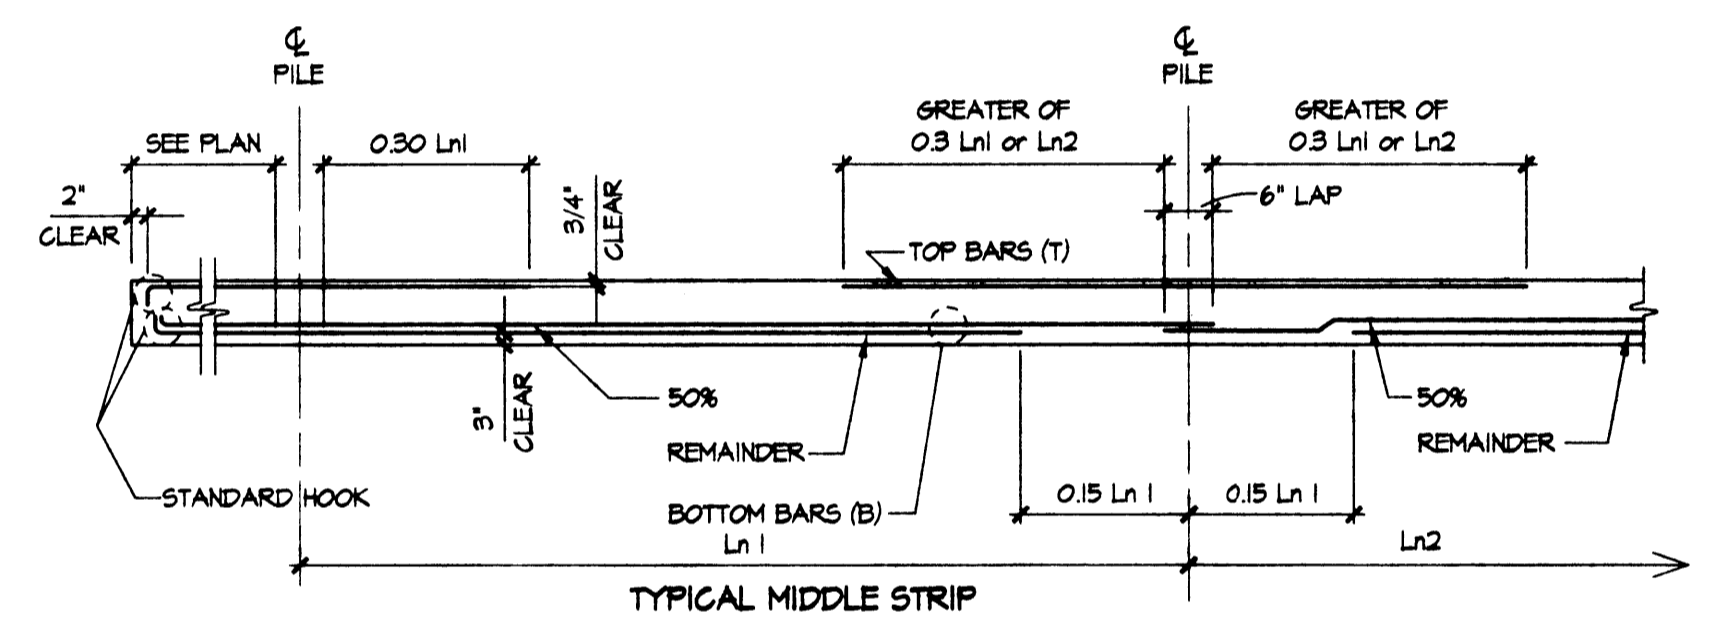


- NOTES:
1. PROVIDE A 6" THICK REINFORCED SLAB. THICKEN SLAB AT PILE LOCATIONS. SEE TYPICAL SECTION THRU SLAB.
  2. TOP OF SLAB ELEVATION TO MATCH EXISTING SLAB.
  3. REFER TO ARCHITECTURAL DRAWINGS FOR LOCATION AND SIZE OF SLAB DEPRESSIONS.
  4. SEE ARCHITECTURAL AND MECHANICAL DRAWINGS FOR OPENINGS NOT SHOWN ON STRUCTURAL DRAWINGS. PROVIDE ADDITIONAL REINFORCING IN SLAB AROUND ALL OPENINGS OR GROUPS OF OPENINGS GREATER THAN 1'-0" IN ANY DIRECTION. REINFORCING EACH SIDE OF OPENINGS (S) IN EACH DIRECTION, TO MATCH 1.5 TIMES AMOUNT OF REINFORCING CUT.
  5. (REF.) = INFORMATION TAKEN FROM REFERENCE DRAWINGS FOR EXISTING CONSTRUCTION PROVIDED BY OWNER.
  6. RECESS TOP OF SLAB FOR SHOWER, APPROX. 40" SQUARE X 2" DEEP. (VERIFY DIMENSIONS WITH EQUIPMENT) THICKEN SLAB AND LOWER REINFORCING FOR 4'-0" ON SIDES OF RECESS.

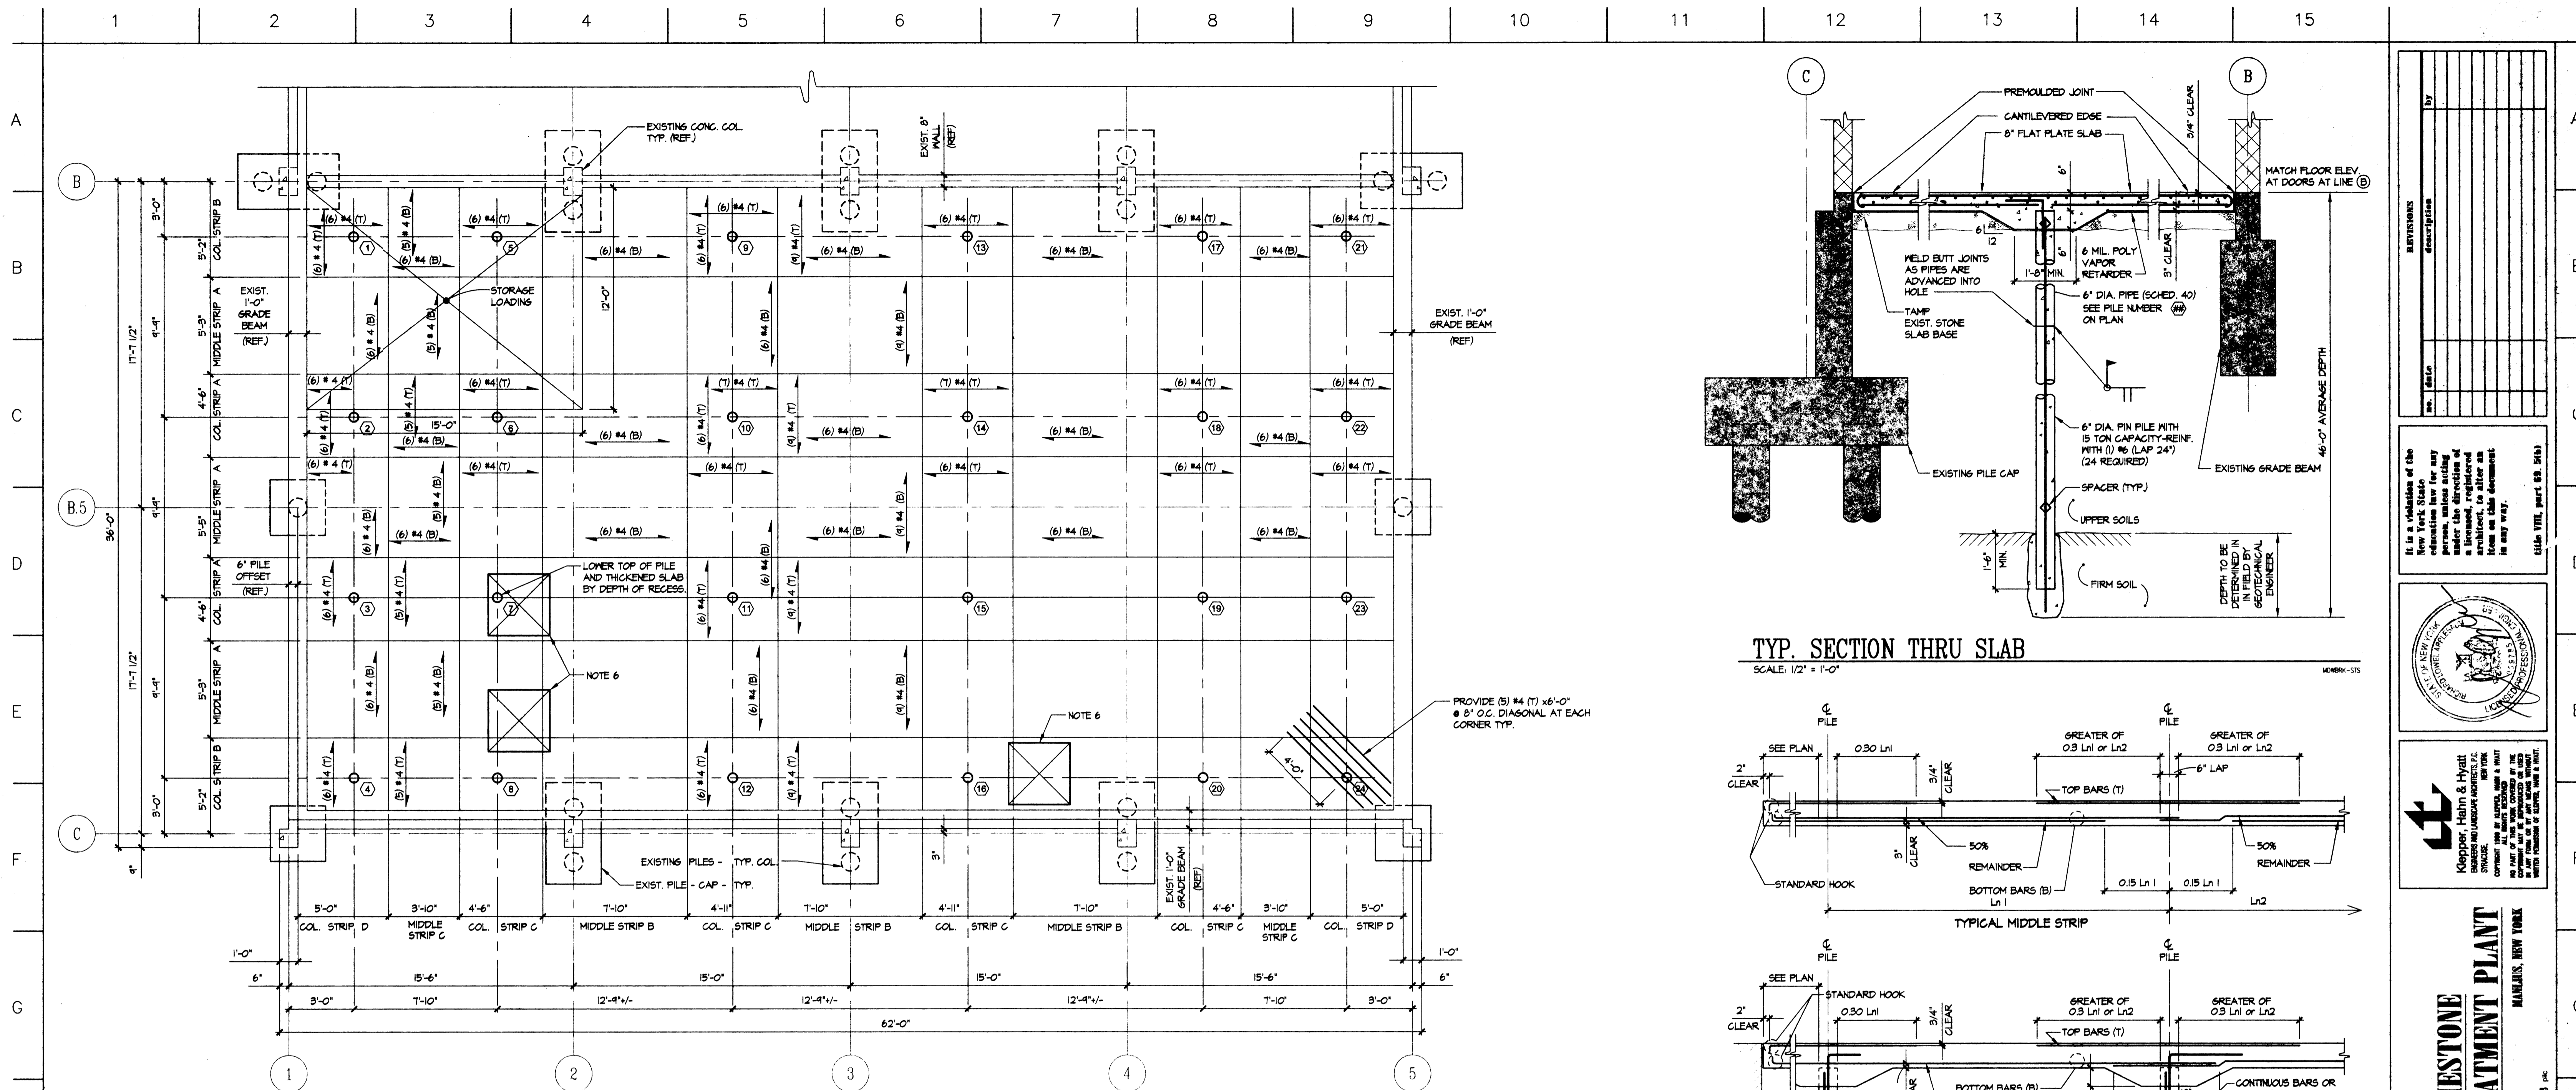
**SLAB PLAN**  
SCALE: 1/4" = 1'-0"




**TYP. SECTION THRU SLAB**  
SCALE: 1/2" = 1'-0"

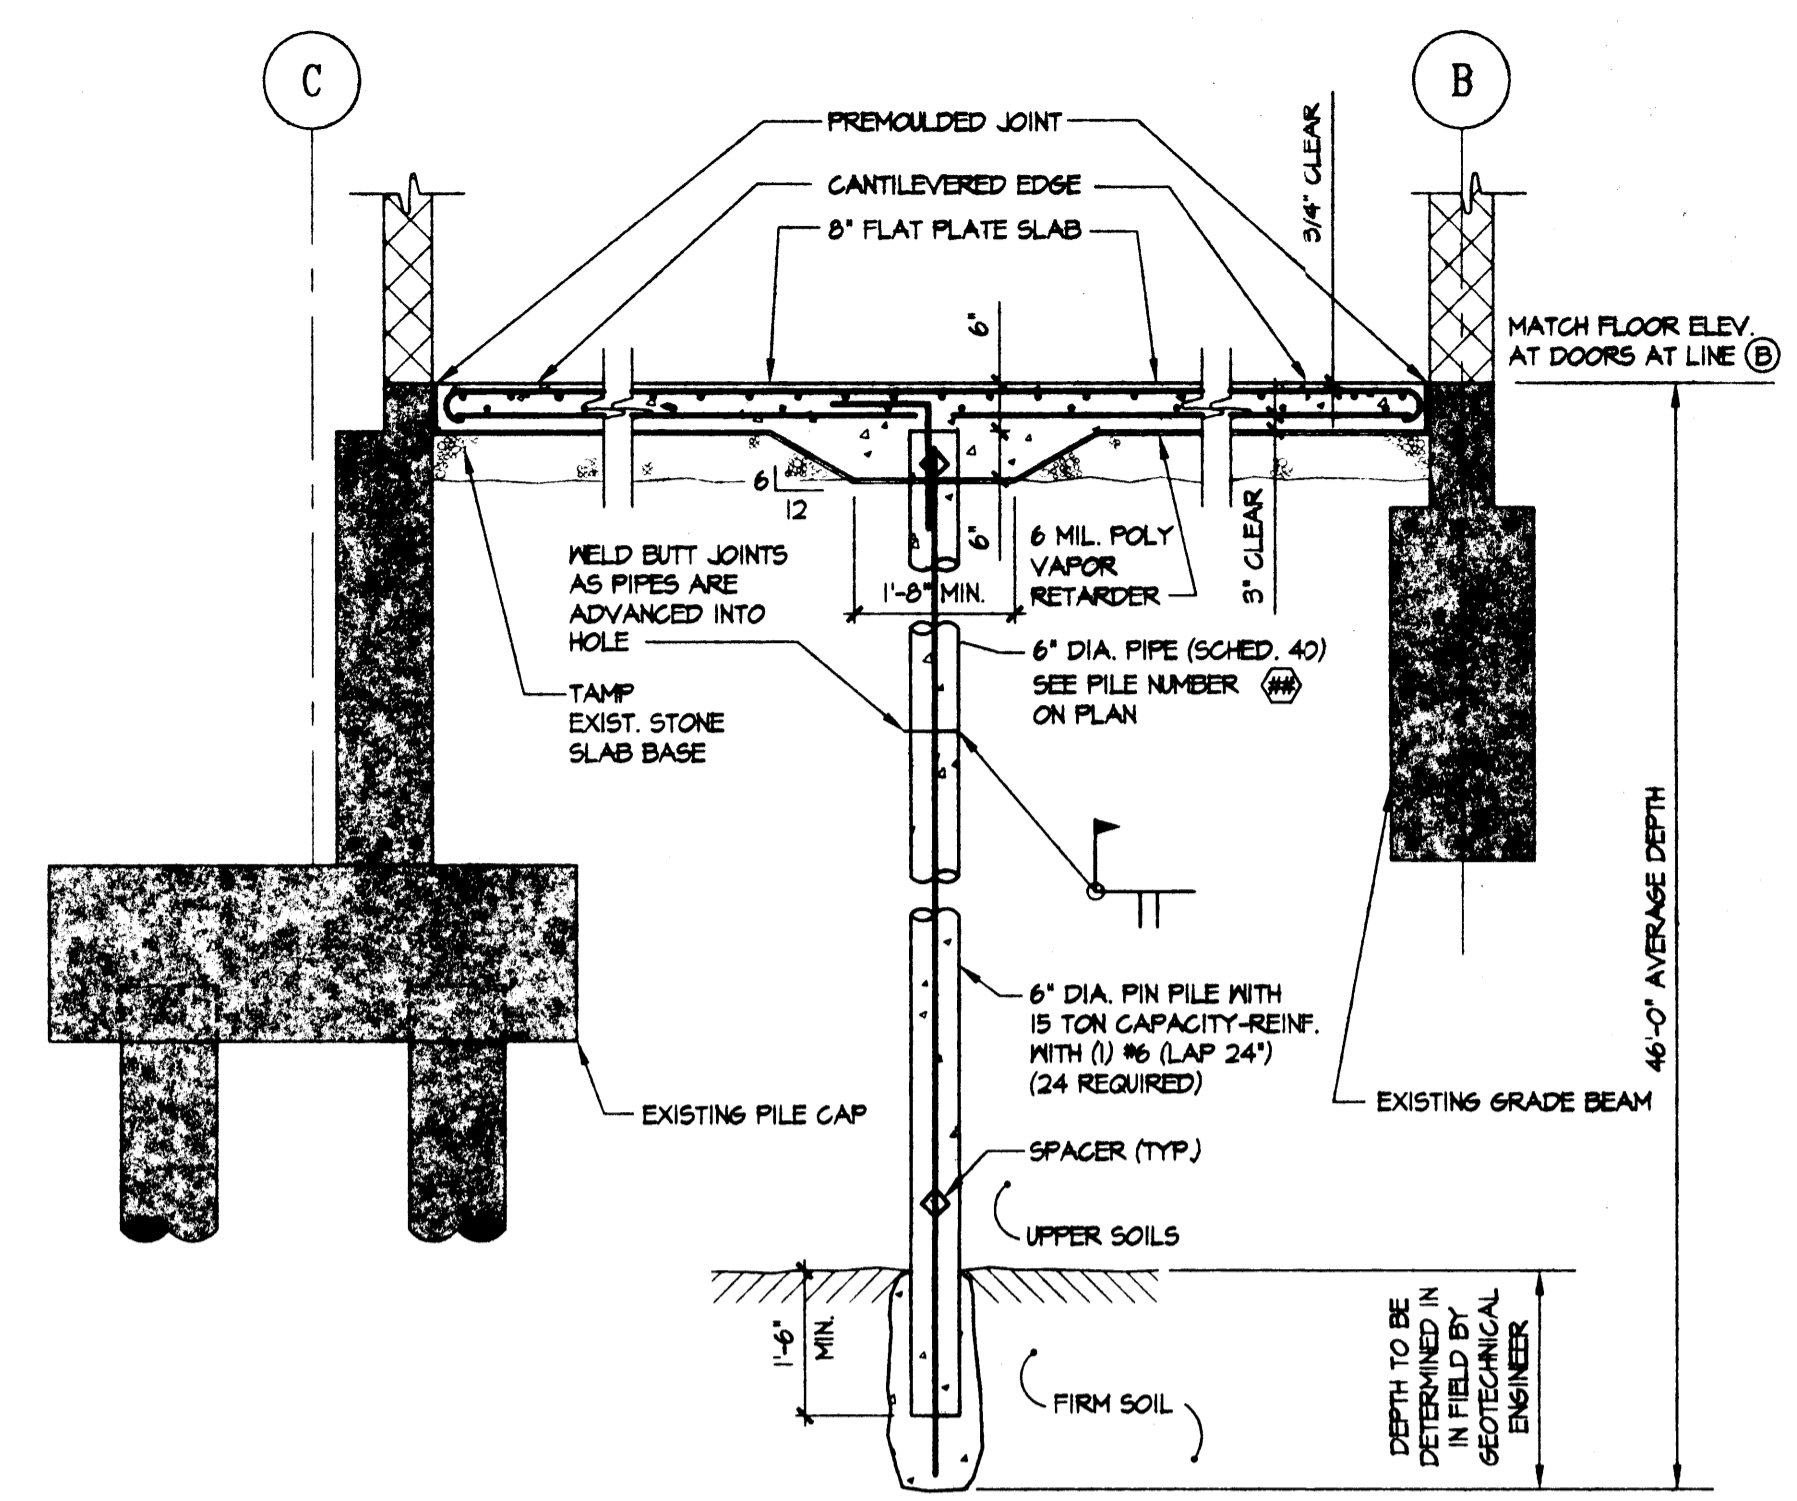

**TYP. FLAT PLATE SLAB**  
SCALE: 1/2" = 1'-0"

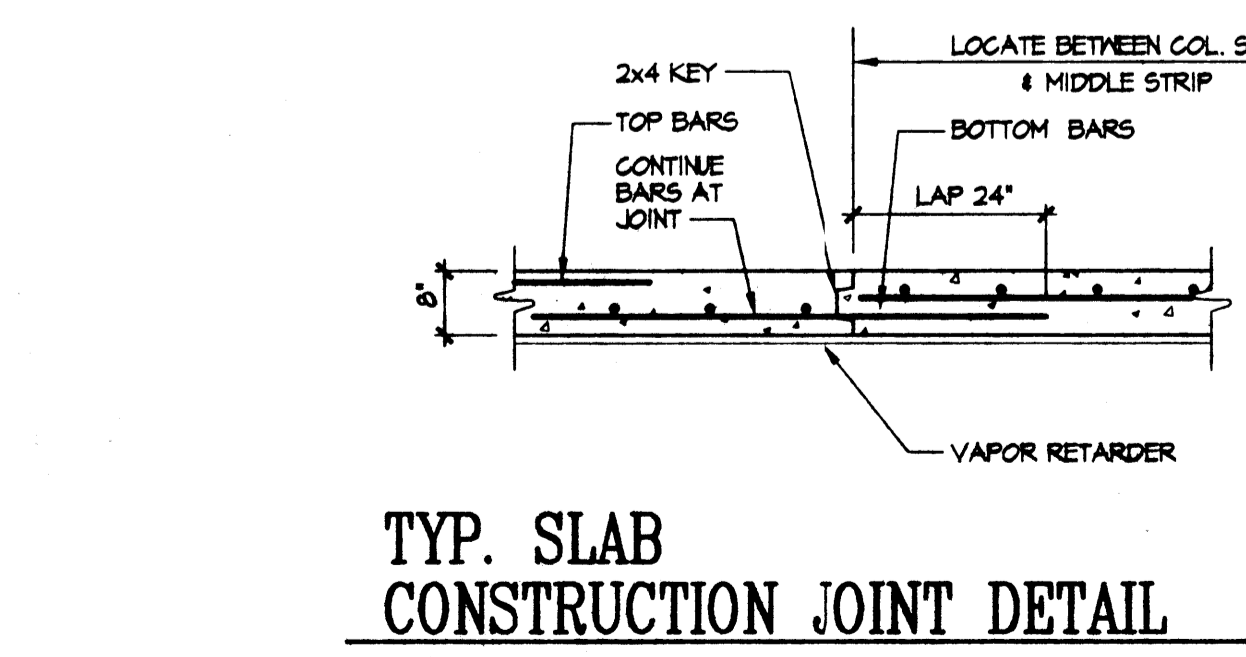

**TYP. SLAB CONSTRUCTION JOINT DETAIL**

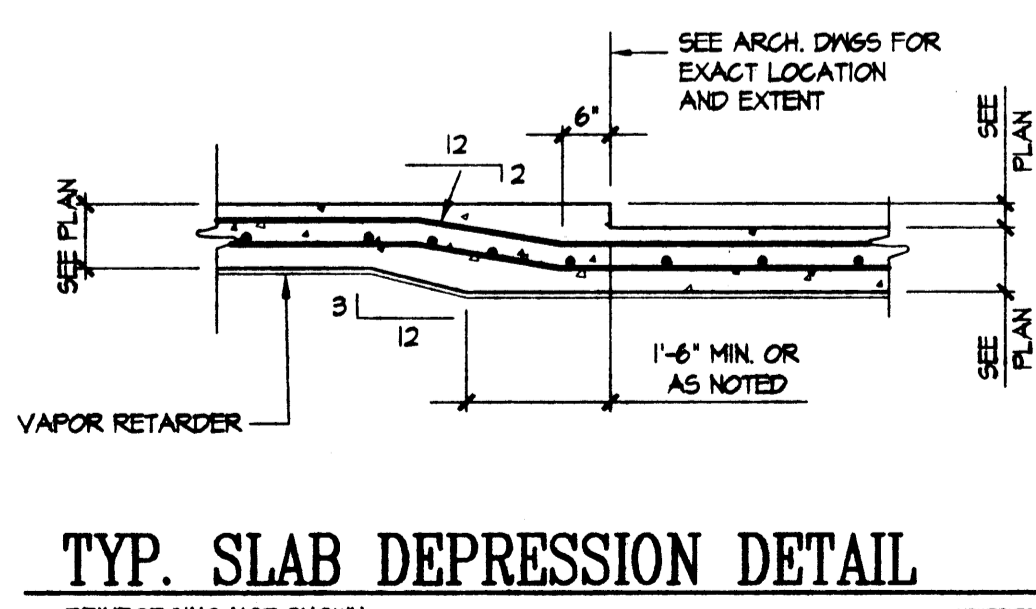

**TYP. SLAB DEPRESSION DETAIL**

INTERIOR LINTEL SCHEDULE FOR NON-BEARING MASONRY PARTITIONS		
MALL THICKNESS	MASONRY OPENING	
	UP TO 4'-0" 4" BEARING EACH END	4'-0" TO 8'-0" 6" BEARING EACH END
4"	L 4x3 1/2 x 3/8 LLV	L 6x3 1/2 x 3/8 LLV
6"	MT 4x4	MT 7x11
8"	(2) - L 5 1/2 x 3 1/2 x 3/8 LLV OR MT 4x12	(2) - L 5 1/2 x 6 3/4 x 3/8 LLV OR MT 7x15

- INTERIOR LINTEL NOTES**
1. LINTELS NOT SHOWN ON STRUCTURAL PLANS.
  2. SEE ARCHITECTURAL & MECHANICAL DRAWINGS FOR LOCATION.
  3. FOR SPECIAL CONDITIONS SEE ARCHITECTURAL SCHEDULES OR SECTIONS.
  4. FOR OPENINGS OVER 8'-0" CONSULT STRUCTURAL ENGINEER.
  5. TACK WELD BACK-TO-BACK VERTICAL LEGS OF MULTIPLE ANGLE LINTELS.

**LIST OF ABBREVIATIONS**

- |               |                       |              |                                    |
|---------------|-----------------------|--------------|------------------------------------|
| ##            | PILE NUMBER           | LLV          | LONG LEGS VERTICAL                 |
| ADDL          | ADDITIONAL            | MAX          | MAXIMUM                            |
| APPROX        | APPROXIMATELY         | MIN          | MINIMUM                            |
| ARCH          | ARCHITECTURAL         | MECH         | MECHANICAL                         |
| B.O.P.        | BOTTOM OF BEARING     | M.O.         | MASONRY OPENING                    |
| C.            | CENTERLINE            | O.C.         | ON CENTER                          |
| C.J.          | CONTROL JOINT         | PL OR P      | PLATE                              |
| CMU           | CONCRETE MASONRY UNIT | PROJ.        | PROJECTION                         |
| COL           | COLUMN                | PSI          | POUNDS PER SQUARE INCH             |
| CONT.         | CONTINUOUS            | REINF        | REINFORCED OR REINFORCING REQUIRED |
| CONG.         | CONCRETE              | SCHED.       | SCHEDULE                           |
| DIA. OR Ø     | DIAMETER              | SECT.        | SECTION                            |
| DWS           | DRAWING               | SIM.         | SIMILAR                            |
| EA.           | EACH                  | SQ.          | SQUARE                             |
| ELEV.         | ELEVATION             | STD.         | STANDARD                           |
| EMBED.        | BAR EMBEDMENT         | T.O.         | TOP OF                             |
| EXIST.        | EXISTING              | T.O.WALL     | TOP OF WALL ELEVATION              |
| EXP.          | EXPANSION             | T.O.SLAB     | TOP OF SLAB ELEVATION              |
| EXT.          | EXTERIOR              | TYP.         | TYPICAL                            |
| F.F.          | FINISH FLOOR          | UNO.         | UNLESS NOTED OTHERWISE             |
| FNDN.         | FOUNDATION            | VERT. OR (V) | VERTICAL                           |
| HORIZ. OR (H) | HORIZONTAL            | VIF.         | VERIFY IN FIELD                    |
| ANGLE         | ANGLE                 | W.P.         | WORKING POINT                      |
| LLH           | LONG LEGS HORIZONTAL  | W            | WITH                               |

**GENERAL NOTES**

1. READ THE SPECIFICATIONS.
2. DESIGN LOADS:
  - A. FLOOR LIVE - 100 PSF
  - 120 PSF AT STORAGE
3. CONSTRUCTION CONTRACTOR TO VERIFY EXISTING CONDITIONS AND DIMENSIONS IN FIELD BEFORE ORDERING MATERIALS. NOTIFY ARCHITECT IMMEDIATELY IF EXISTING CONDITIONS DIFFER FROM THE INTENT OF THESE DRAWINGS.
4. PIN PILES: AUGER CAST, REINFORCED CONCRETE PILES IN PILE SLEEVES.
5. CONCRETE:
  - A. DESIGN STRENGTH - 4000 PSI @ 28 DAYS
  - B. DESIGN STANDARD - ACI 318
  - C. DETAIL STANDARD - CRSI - MANUAL OF STANDARD PRACTICE.
6. CONCRETE REINFORCING:
  - A. DEFORMED BARS - ASTM A615, GRADE 60
7. CONCRETE COVER OVER BARS: (ALSO SEE ACI 318)
  - A. FLOOR SLABS - 3/4" CLEAR FROM TOP
  - 3" CLEAR FROM BOTTOM
8. PROVIDE ALL NECESSARY TIE BARS, SPACER BARS, CHAIRS, ETC.
9. SECTIONS AND DETAILS ARE CONTINUOUS AND TYPICAL UNLESS NOTED OTHERWISE.

REVISIONS

NO.	DATE	DESCRIPTION

It is a violation of the New York State Professional Engineering Law to practice engineering without being a licensed professional engineer, to alter an issue on this document in any way.

STATE OF NEW YORK  
REGISTERED PROFESSIONAL ENGINEER  
EXPIRES 12/31/2008  
L. C. KEEPER

KEEPER, HEATH & HYATT  
REGISTERED PROFESSIONAL ENGINEERS  
SYRACUSE, NEW YORK  
NO PART OF THIS WORK COVERED BY THIS CONTRACT SHALL BE REPRODUCED OR TRANSMITTED IN ANY FORM OR BY ANY MEANS, ELECTRONIC OR MECHANICAL, WITHOUT PERMISSION OF KEPPER, HEATH & HYATT.

GARAGE HOPIGATIONS AT:  
**MEADOWBROOK-LIMESTONE**  
**WASTEWATER TREATMENT PLANT**  
MADISON, NEW YORK

sheet title  
**NEW SLAB FOR GARAGE BUILDING**

drawn \_\_\_\_\_ TSH  
checked \_\_\_\_\_ DMG  
date 4/2/2008  
khh file no. 44008

sheet no. **S1**









# ROOM FINISH SCHEDULE

NO.	NAME	FLOOR	BASE	WALLS								CEILING		REMARKS				
				NORTH	EAST	SOUTH	WEST	COL.	PT.	COL.	PT.	MAT.	FIN.		HGT.			
101	VEHICLE STORAGE	EX	-	EX	-	EX	-	EX	-	EX	-	EX	-	EX	-	EX	-	EX
102	STOCK ROOM	CONC.	-	-	-	-	-	-	-	-	-	-	-	-	-	-	-	VARIES
103	CORRIDOR	VGT	-	VE	-	VE	-	VE	-	VE	-	VE	-	VE	-	VE	-	VARIES
104	ELECTRICAL ROOM	CONC.	-	-	-	-	-	-	-	-	-	-	-	-	-	-	-	PROVIDE PLASTIC SIGN / ELECTRIC ROOM
105	EMPLOYEE LOUNGE	VGT	-	VE	-	VE	-	VE	-	VE	-	VE	-	VE	-	VE	-	VARIES
106	OFFICE	VGT	-	VE	-	VE	-	VE	-	VE	-	VE	-	VE	-	VE	-	VARIES
107	WOMEN'S TOILET/SHOWER	CMT	-	CT	-	CT	-	CT	-	CT	-	CT	-	CT	-	CT	-	VARIES
108	MEN'S TOILET/SHOWER	CMT	-	CT	-	CT	-	CT	-	CT	-	CT	-	CT	-	CT	-	VARIES
109	CORRIDOR	VGT	-	VE	-	VE	-	VE	-	VE	-	VE	-	VE	-	VE	-	VARIES


- NOTES:
- 1 MATERIAL / FINISH IN BRACKETS ( ) = EXISTING
  - 2 • = TO BE SELECTED
  - 3 PAINT ALL EXPOSED DUCTWORK THROUGHOUT, CONDUIT, ETC.
  - 4 FOR SIGNAGE SEE SPEC

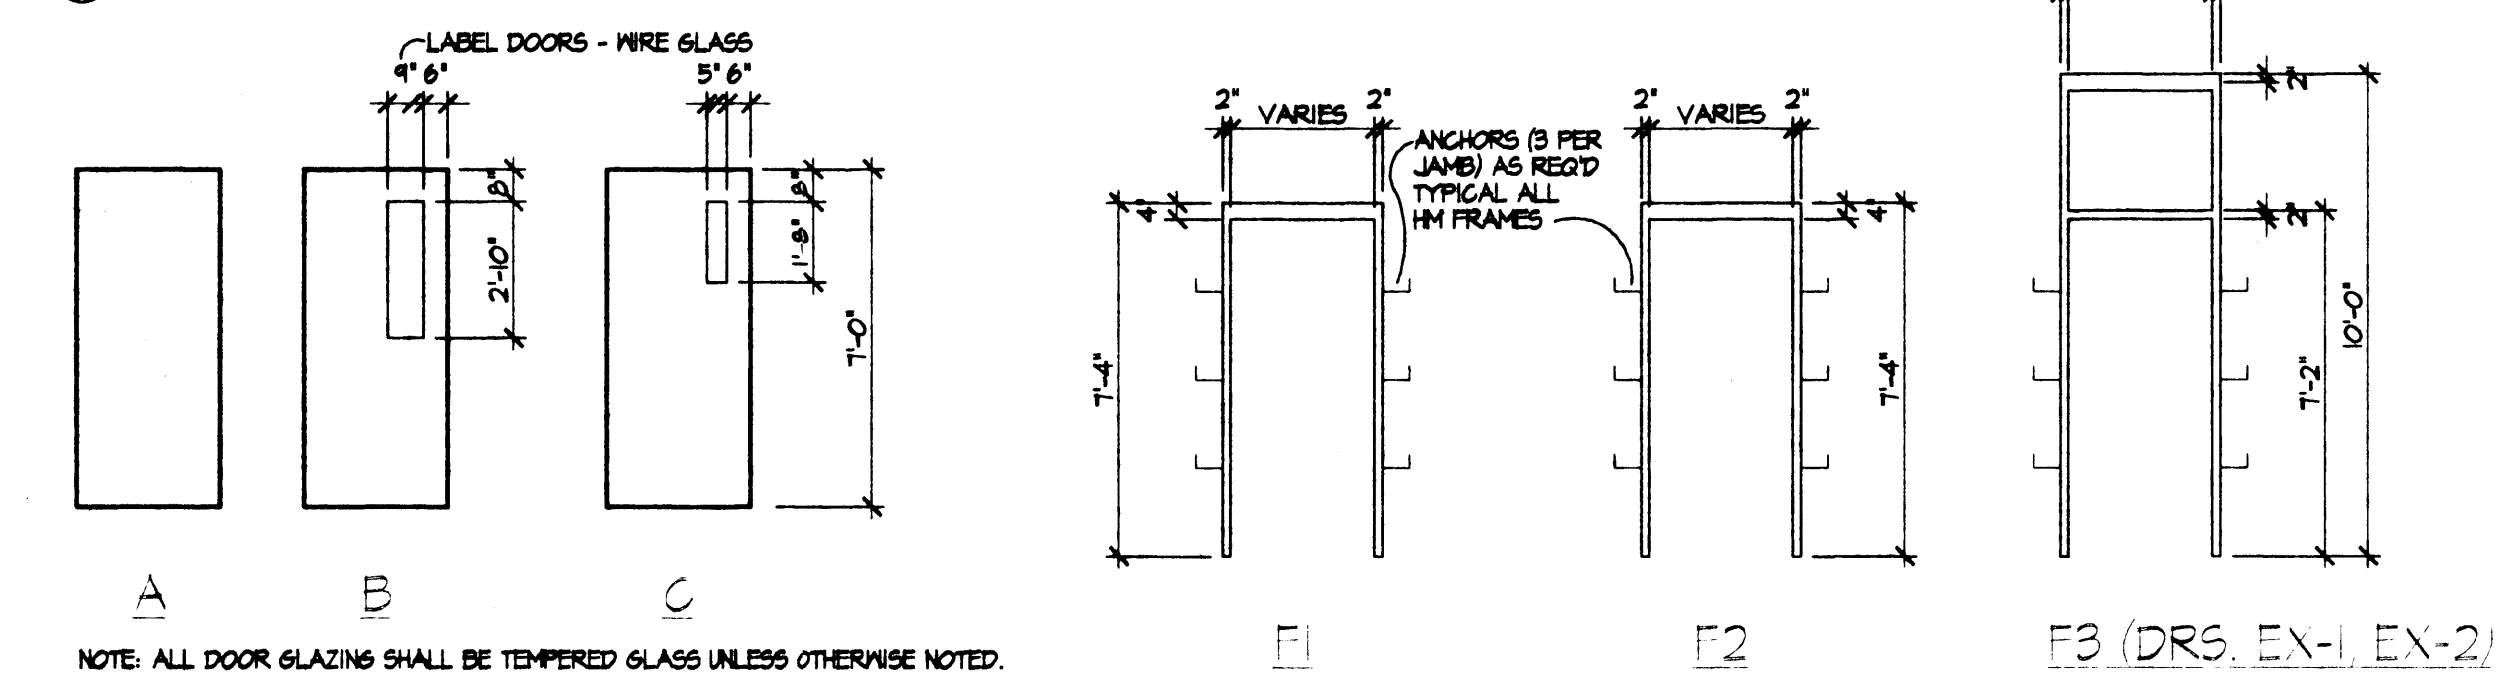

F1 DOOR TYPES scale: 1/4" = 1'-0"  
 F2 DOOR FRAME TYPES scale: 1/4" = 1'-0"  
 F3 (DRS. EX-1, EX-2)

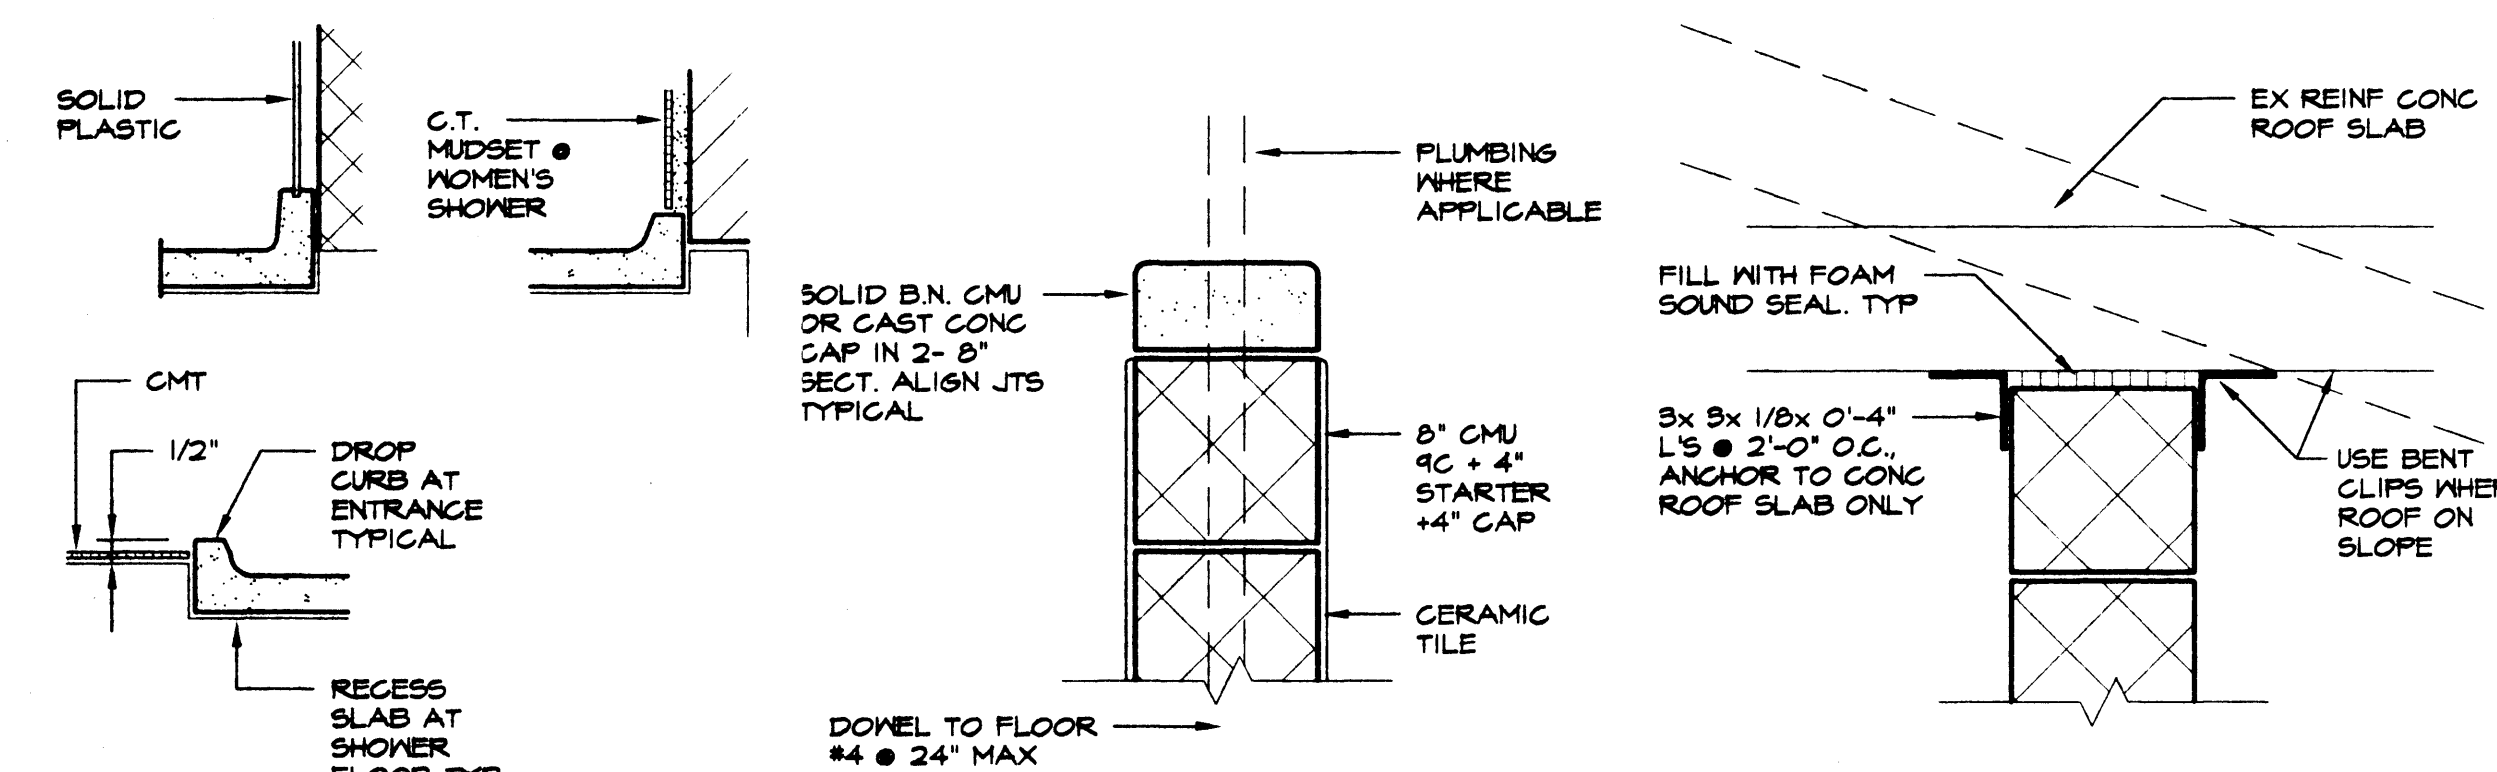


H1 SHOWER FLR RECEPTORS scale: 1 1/2" = 1'-0"  
 H3 LOW WALL DETAIL scale: 1 1/2" = 1'-0"  
 H5 DETAIL / T.O. BLK PARTITION scale: 1 1/2" = 1'-0"

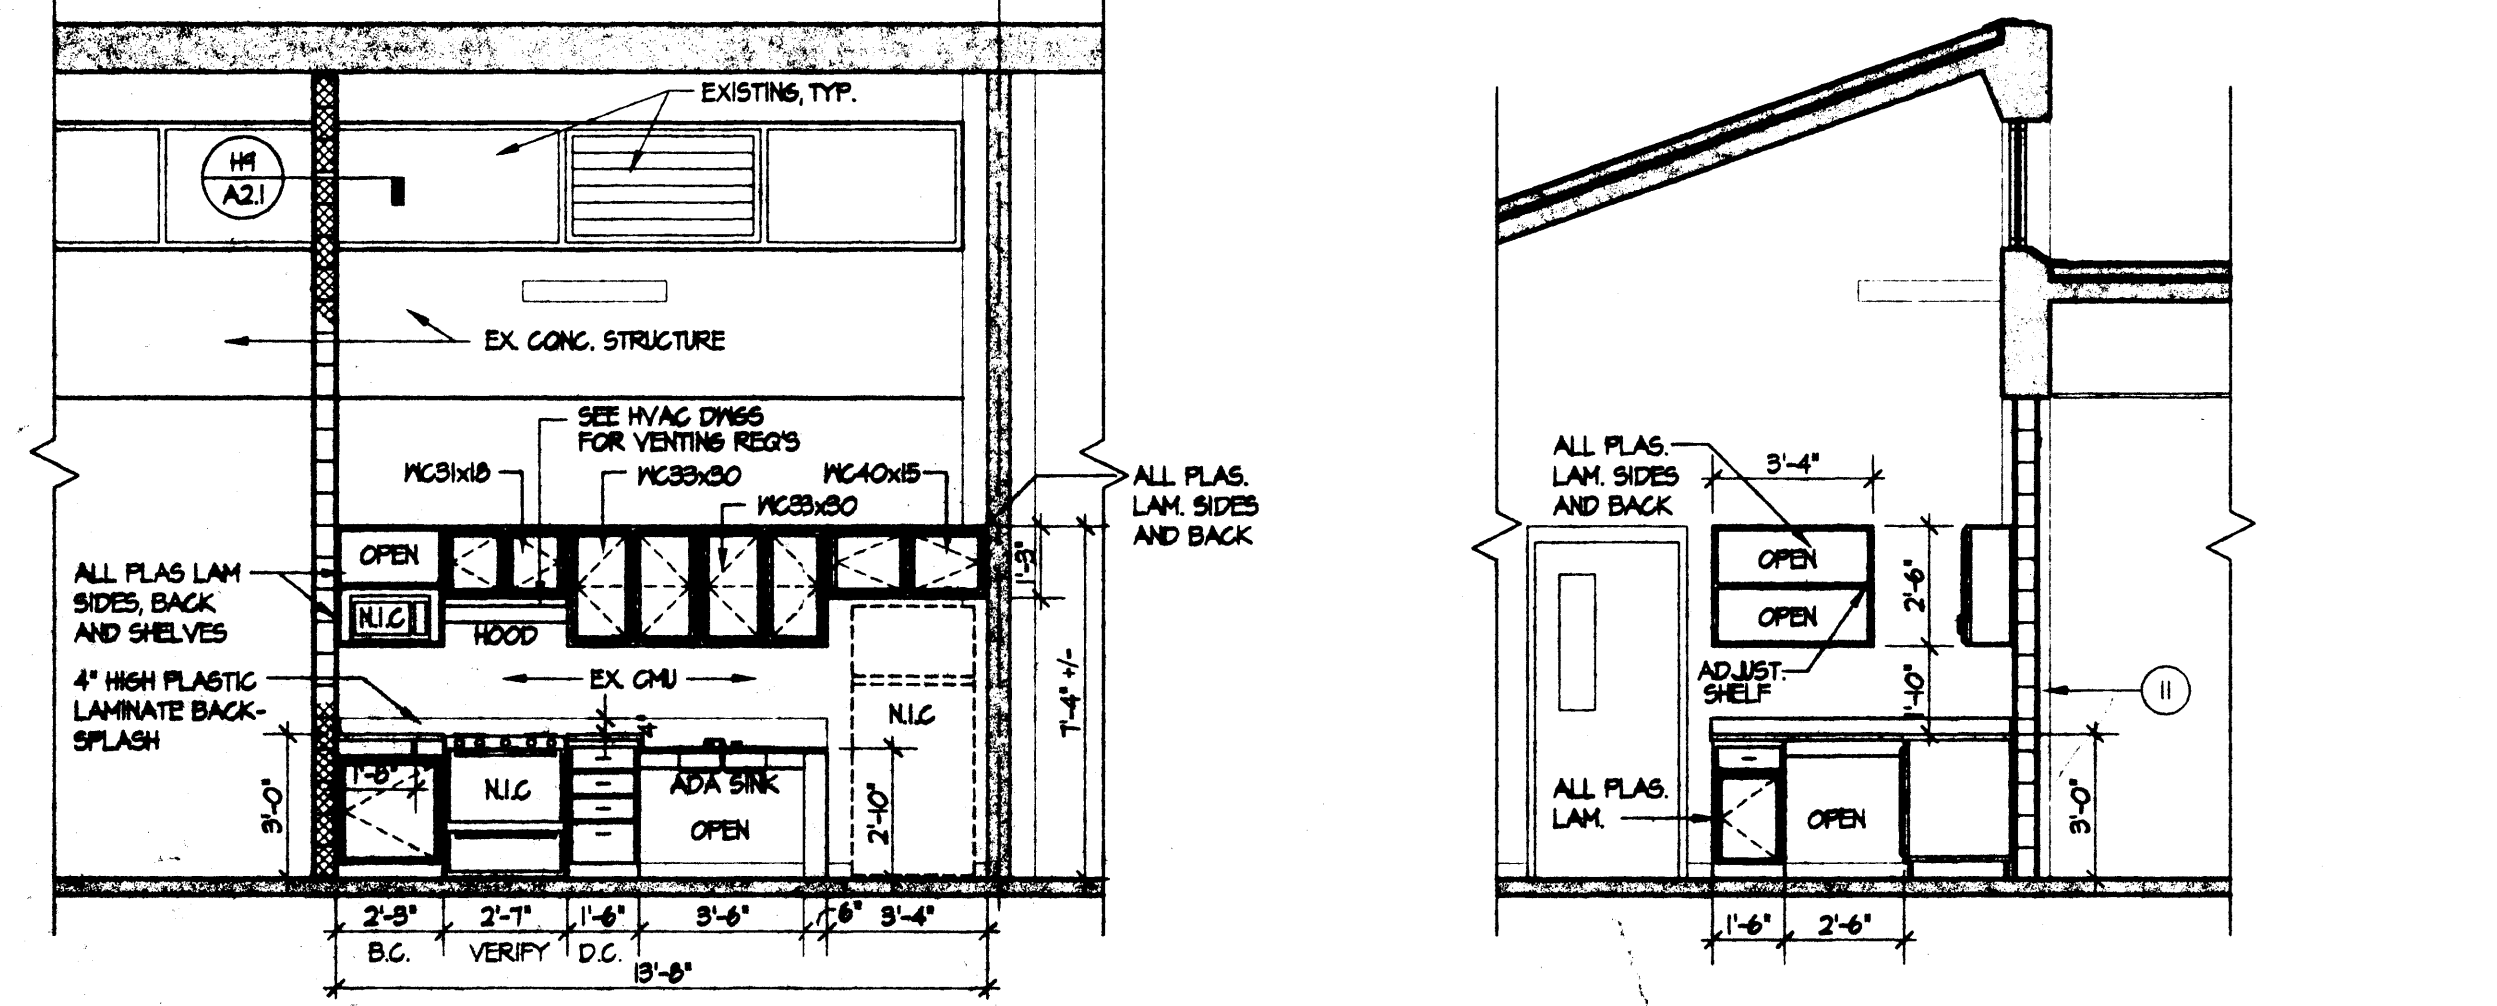


L1 ELEVATION- EMPLOYEE LOUNGE scale: 1/4" = 1'-0"  
 L4 ELEVATION- EMPLOYEE LOUNGE scale: 1/4" = 1'-0"

# DOOR SCHEDULE

DOOR NO.	LOCATION	LOCATION FROM TO	DOOR				FRAME				THOLD	LINTEL	HDWR GROUP	LABEL	REMARKS		
			MAT	TYPE	QTY	WIDTH	HGT	THK	FIN	MAT						WIDTH	JAMB
EX-1	EXTERIOR	CORRIDOR 109	HM	B	1	3'-0"	7'-0"	1 3/4"	PT	HM	6"	L1/A2.1	L1/A2.1	YES	-	1	-
EX-2	EXTERIOR	CORRIDOR 109	HM	B	1	3'-0"	7'-0"	1 3/4"	PT	HM	6"	A2.1	L1/A2.1	YES	-	1	-
102	VEHICLE STORAGE 101	STOCK ROOM 102	HM	C	1	3'-0"	7'-0"	1 3/4"	PT	HM	6 3/4"	F1/A2.1	F1/A2.1	-	-	4	B
103	CORRIDOR 109	CORRIDOR 103	HM	B	1	3'-0"	7'-0"	1 3/4"	PT	HM	6 3/4"	F1/A2.1	F1/A2.1	-	-	5	-
103A	EX. GARAGE	CORRIDOR 103	HM	C	1	3'-0" (F.V.)	7'-0" (F.V.)	1 3/4"	PT	EX. HM	-	-	-	-	EX.	5	B
104	CORRIDOR 109	ELECTRICAL ROOM 104	HM	B	1	3'-0"	7'-0"	1 3/4"	PT	HM	6 3/4"	F1/A2.1	F1/A2.1	-	-	2	-
105	CORRIDOR 109	EMPLOYEE LOUNGE 105	HM	B	1	3'-0"	7'-0"	1 3/4"	PT	HM	6 3/4"	F1/A2.1	F1/A2.1	-	-	2	-
105A	CORRIDOR 109	EMPLOYEE LOUNGE 105	HM	B	1	3'-0"	7'-0"	1 3/4"	PT	HM	6 3/4"	F1/A2.1	F1/A2.1	-	-	2	-
106	CORRIDOR 109	OFFICE 106	HM	B	1	3'-0"	7'-0"	1 3/4"	PT	HM	6 3/4"	F1/A2.1	F1/A2.1	-	-	2	-
106A	CORRIDOR 109	OFFICE 106	HM	B	1	3'-0"	7'-0"	1 3/4"	PT	HM	6 3/4"	F1/A2.1	F1/A2.1	-	-	2	-
107	CORRIDOR 109	WOMEN'S TOILET/SHOWER	HM	A	1	3'-0"	7'-0"	1 3/4"	PT	HM	6 3/4"	F1/A2.1	F1/A2.1	-	-	6	-
108	CORRIDOR 109	MEN'S TOILET/SHOWER	HM	A	1	3'-0"	7'-0"	1 3/4"	PT	HM	6 3/4"	F1/A2.1	F1/A2.1	-	-	6	-

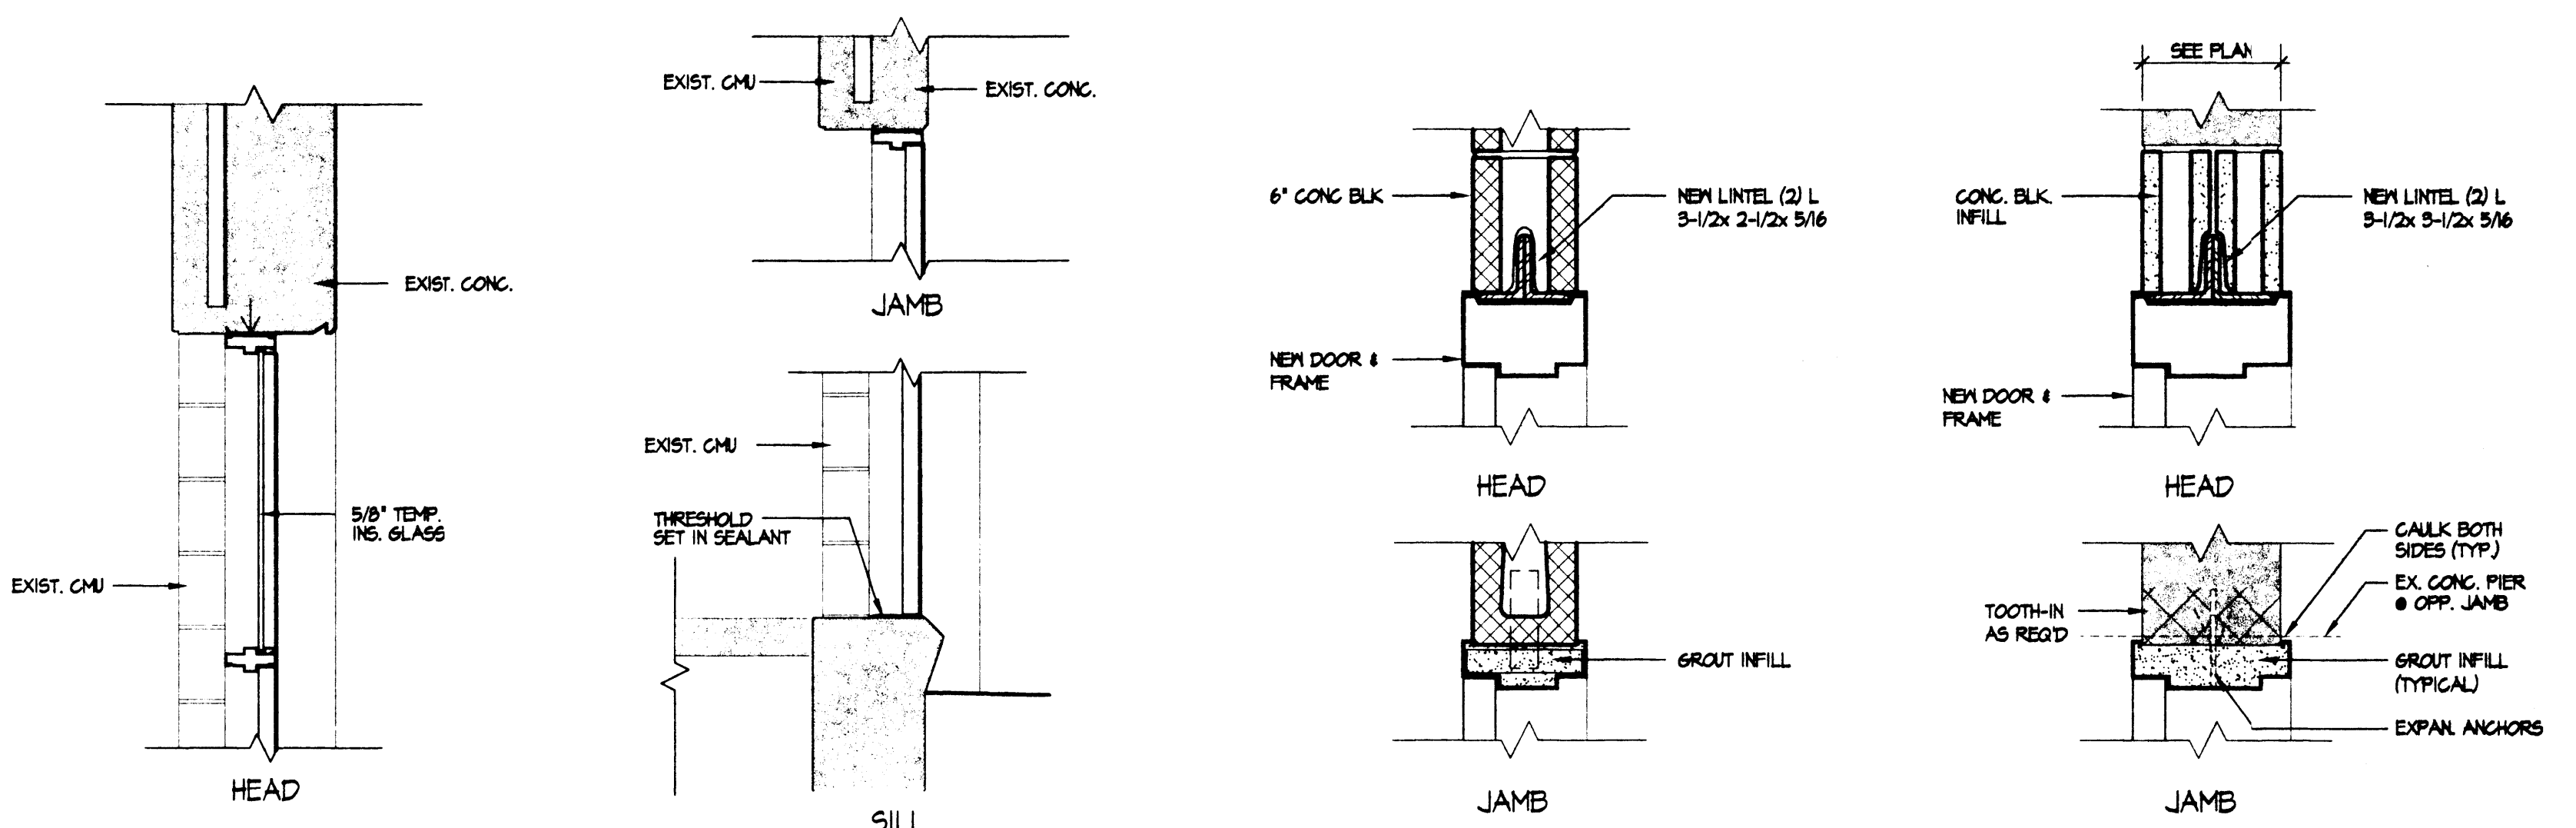

F7 DETAIL @ DOOR EX-1 scale: 3/4" = 1'-0"  
 F9 DETAIL @ DOOR EX-2 scale: 3/4" = 1'-0"  
 F11 DOOR DETAIL @ NEW WALLS scale: 1 1/2" = 1'-0"  
 F13 DOOR DETAIL @ EXISTING WALL scale: 1 1/2" = 1'-0"

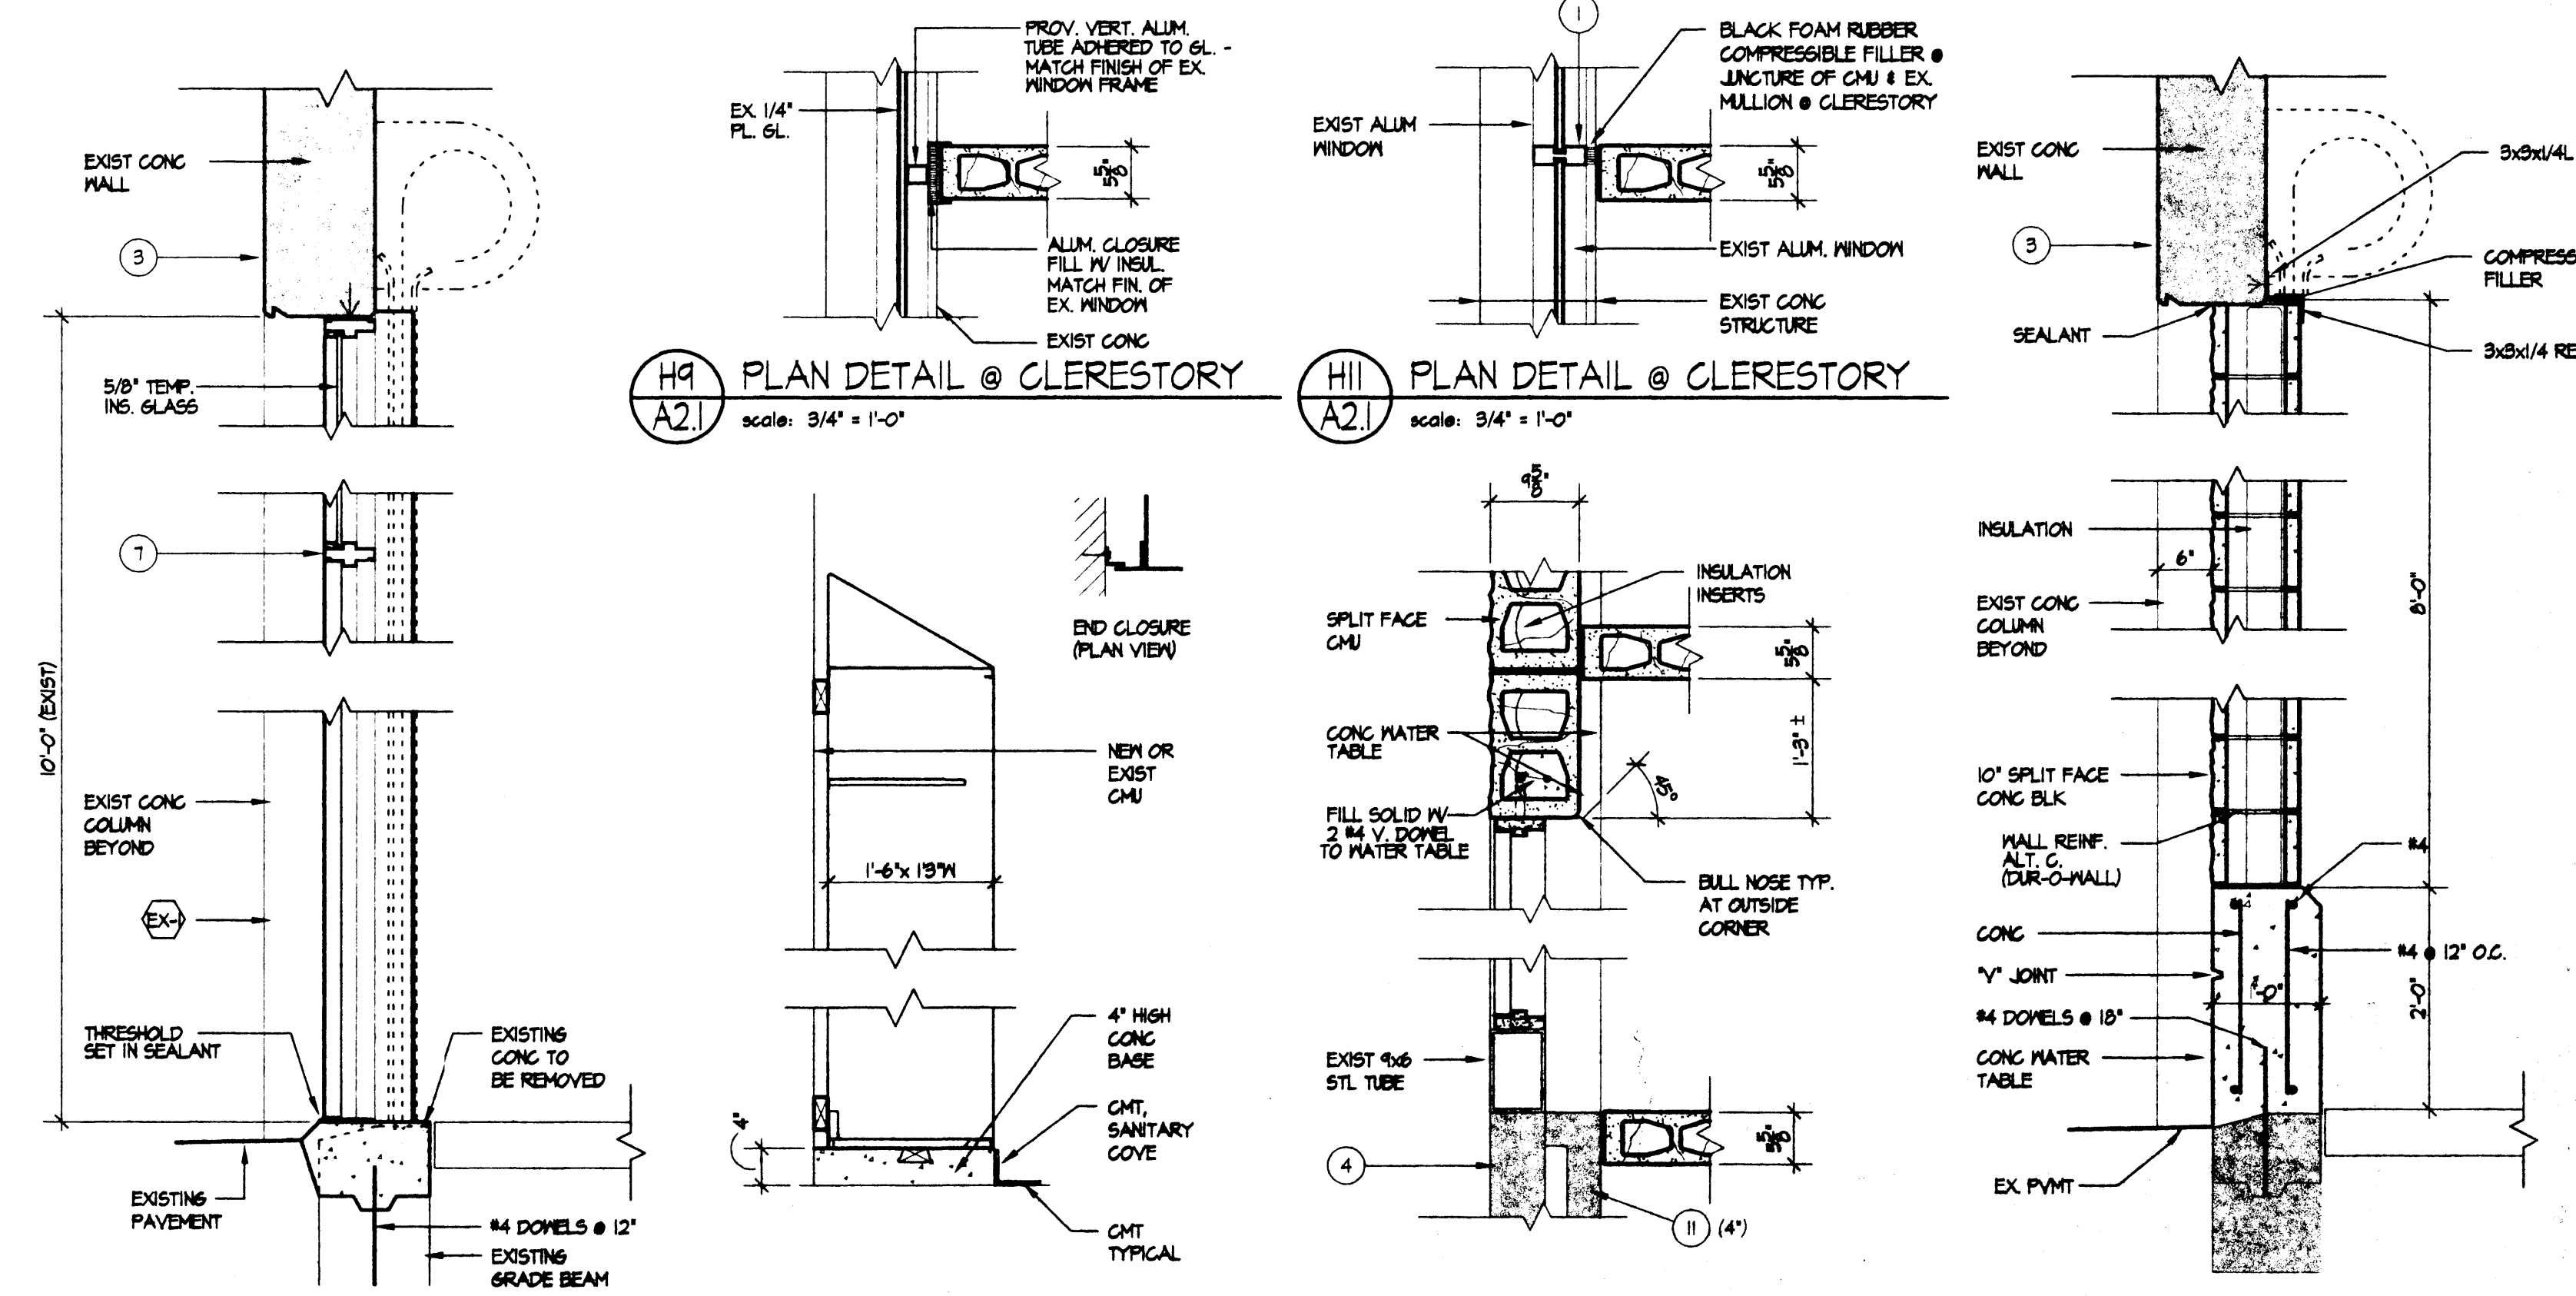

H9 PLAN DETAIL @ CLERESTORY scale: 3/4" = 1'-0"  
 H11 PLAN DETAIL @ CLERESTORY scale: 3/4" = 1'-0"  
 L7 WALL SECTION @ DOOR EX-1 scale: 3/4" = 1'-0"  
 L9 LOCKER SECTION scale: 3/4" = 1'-0"  
 L11 PLAN DETAIL scale: 3/4" = 1'-0"  
 L13 WALL SECTION scale: 3/4" = 1'-0"

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REGISTERED ARCHITECT  
 MEADOWBROOK-LIMESTONE  
 WASTEWATER TREATMENT PLANT  
 TOWNSHIP OF MANTON  
 PRELIMINARY - FIELDWORK / AS-BUILT DRAWINGS  
 MANHATTAN, NEW YORK

sheet title  
**DOOR & ROOM FINISH SCHED. AND MISC DETAILS**

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